


**MEZZANINE FRAMING PLAN**

1/4" = 1'-0"

**NOTES**

1. REFER TO DRAWING S100 FOR GENERAL NOTES
2. MEZZANINE FLOOR DESIGNED FOR THE FOLLOWING SUPERIMPOSED SERVICE LOADS:  
DEAD LOAD = 15 psf  
LIVE LOAD = 100 psf
3. PROVIDE 4 PLY BUILT-UP COLUMNS AT EACH END OF ALL LINTELS. COLUMN TO CONSIST OF 2 FULL HT. STUDS AND 2 CRIPPLE STUDS.
4. REFER TO DWG S203 FOR WOOD BEAM SCHEDULE.

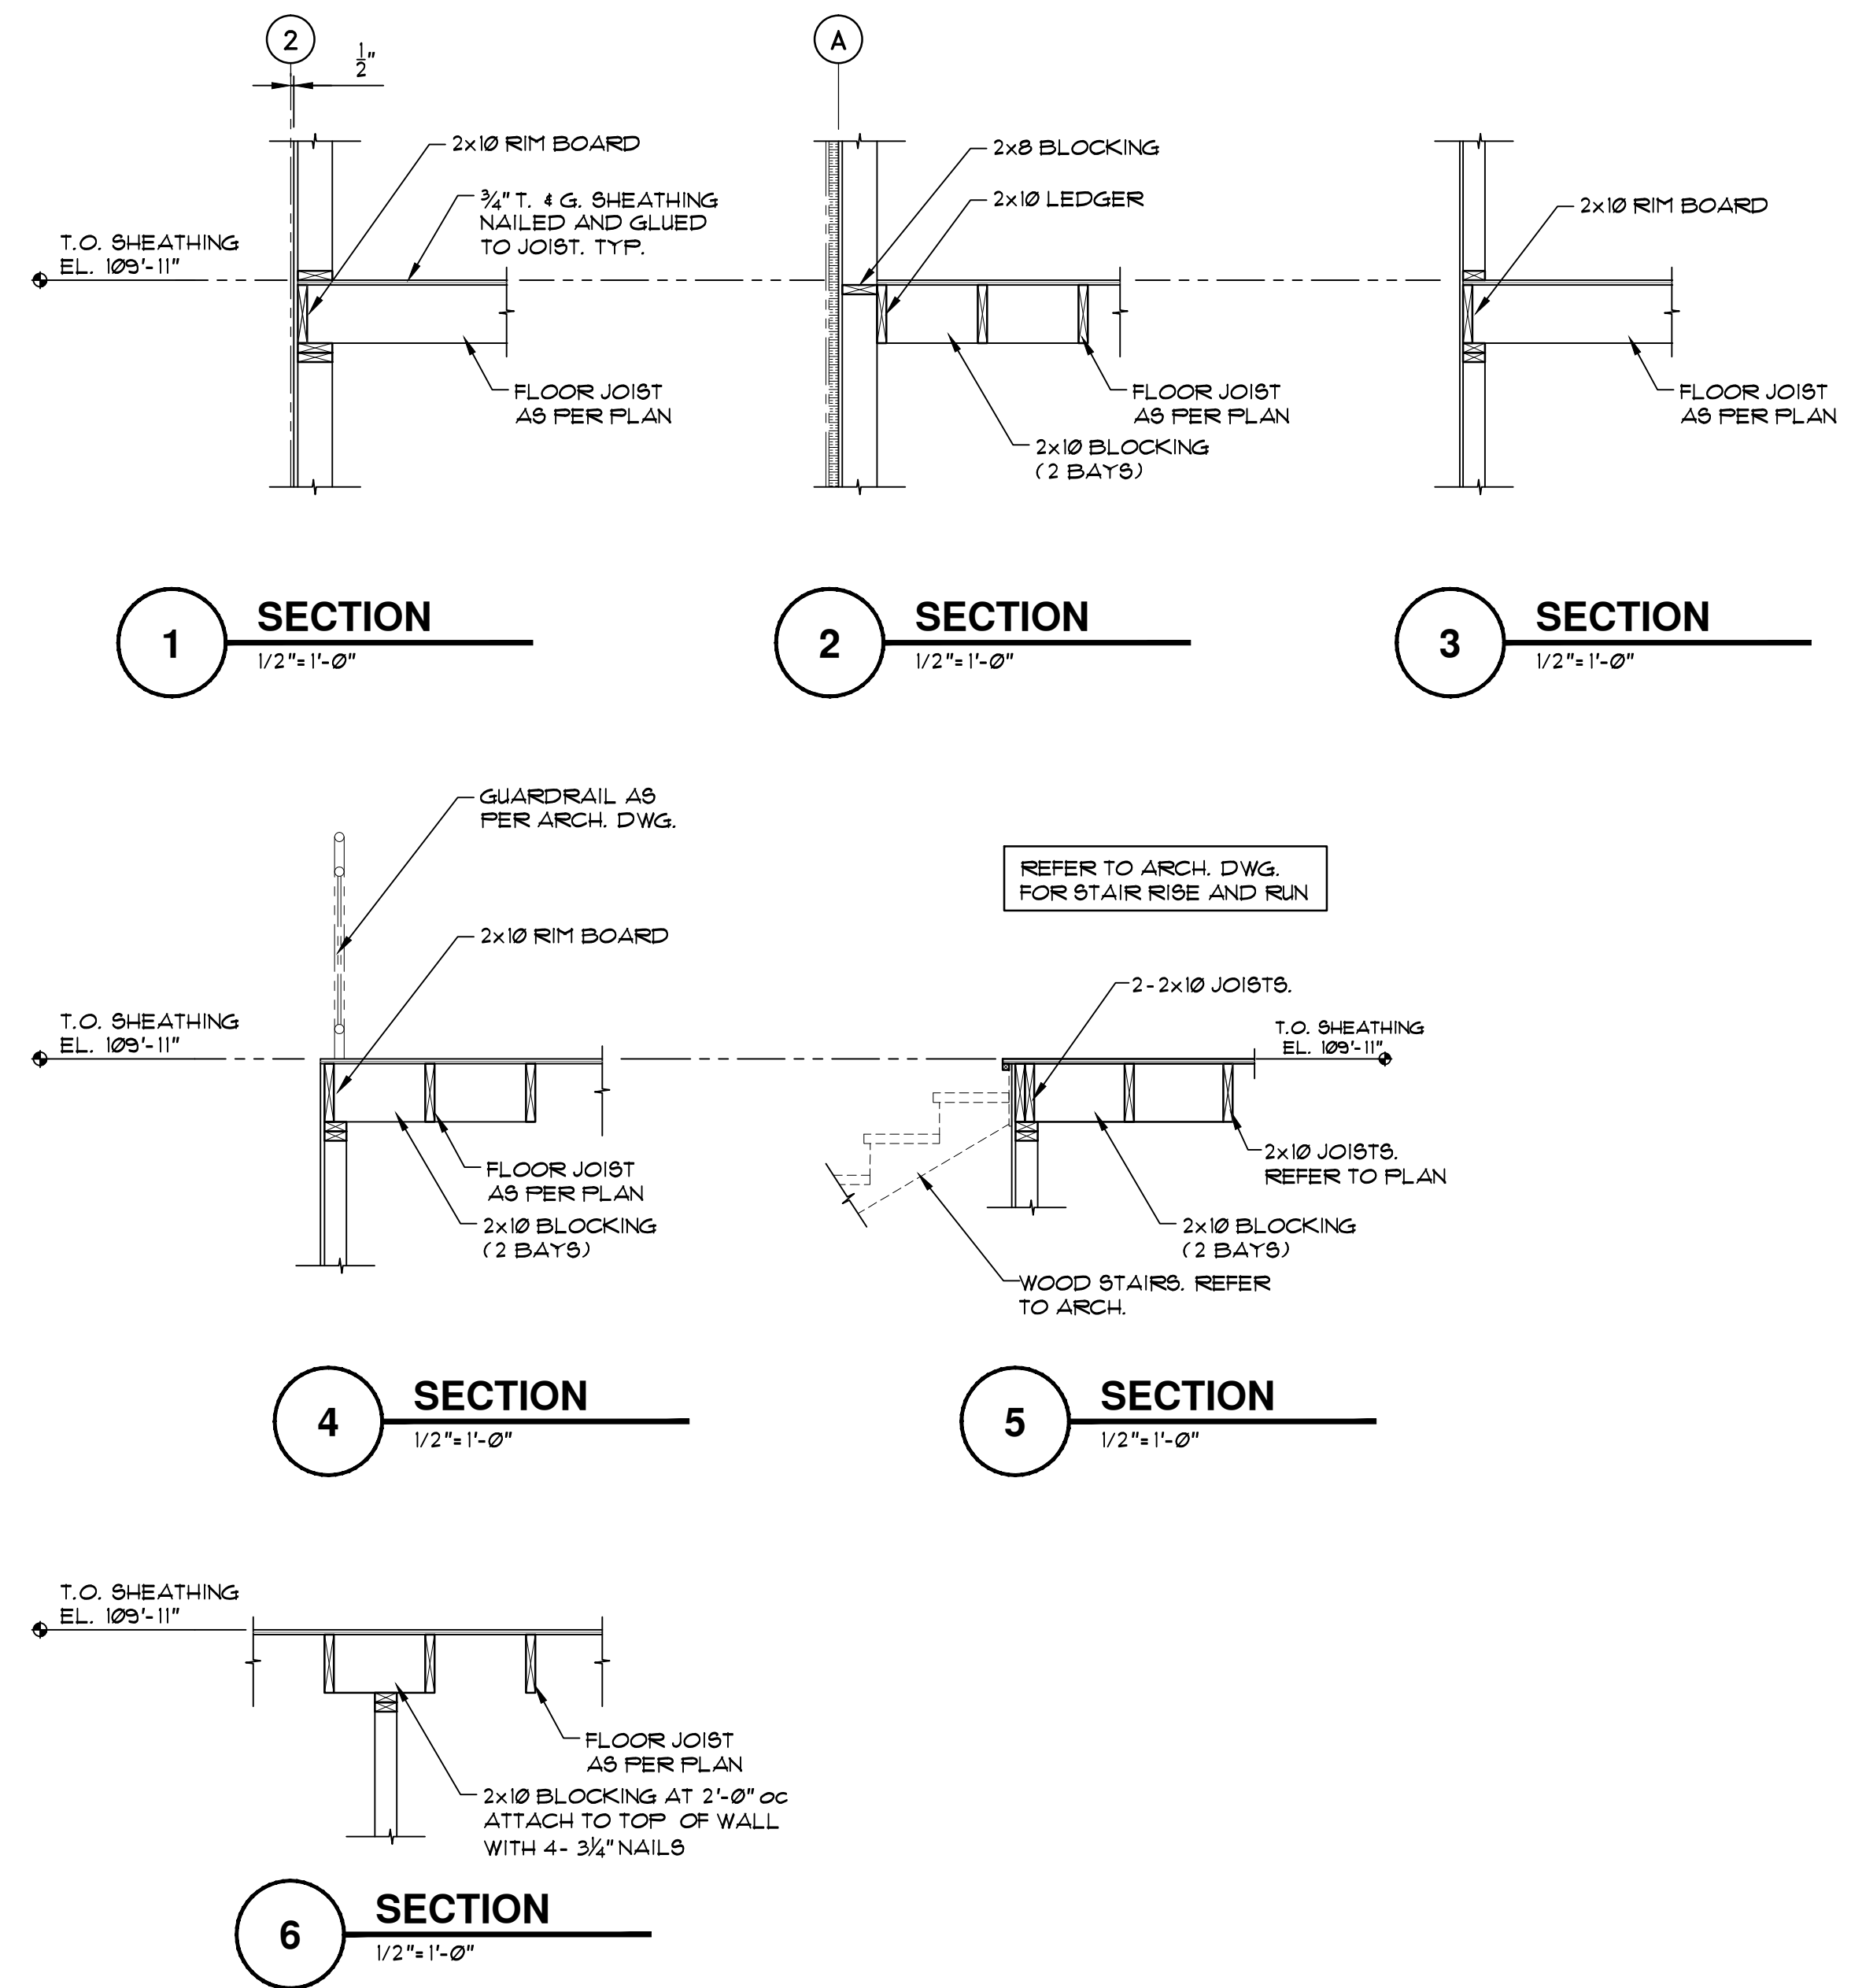

DO NOT SCALE DRAWING. VERIFY ALL DIMENSIONS, DATA & ELEVATIONS PRIOR TO COMMENCEMENT OF WORK. COPYRIGHT OF RBM ARCHITECTURE INC.

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A - ISSUED FOR REVIEW 16/12/2024

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ASSOCIATION OF PROFESSIONAL ENGINEERS AND GEOSCIENTISTS OF SASKATCHEWAN  
CERTIFICATE OF AUTHORIZATION  
ETS ENGINEERING CORPORATION  
NUMBER 20638  
PERMISSION TO CONSULT HELD BY:  
DISCIPLINE: S.A.S. REG. NO. \_\_\_\_\_  
STRUCTURAL 2975 \_\_\_\_\_

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PROJECT:  
**WYNYARD  
RECYCLING DEPOT**

DRAWING:  
**MEZZANINE FLOOR  
FRAMING PLAN  
AND SECTIONS**

PROJECT No: T51-16 SHEET No: FLOT No: 1  
DATE: 10/26/2016  
DRAWN BY: -  
SCALE: 1/8" = 1'-0"  
**S202**